


OUTDOOR KITCHEN FLOOR PLAN
SCALE: 1/4" = 1'-0"

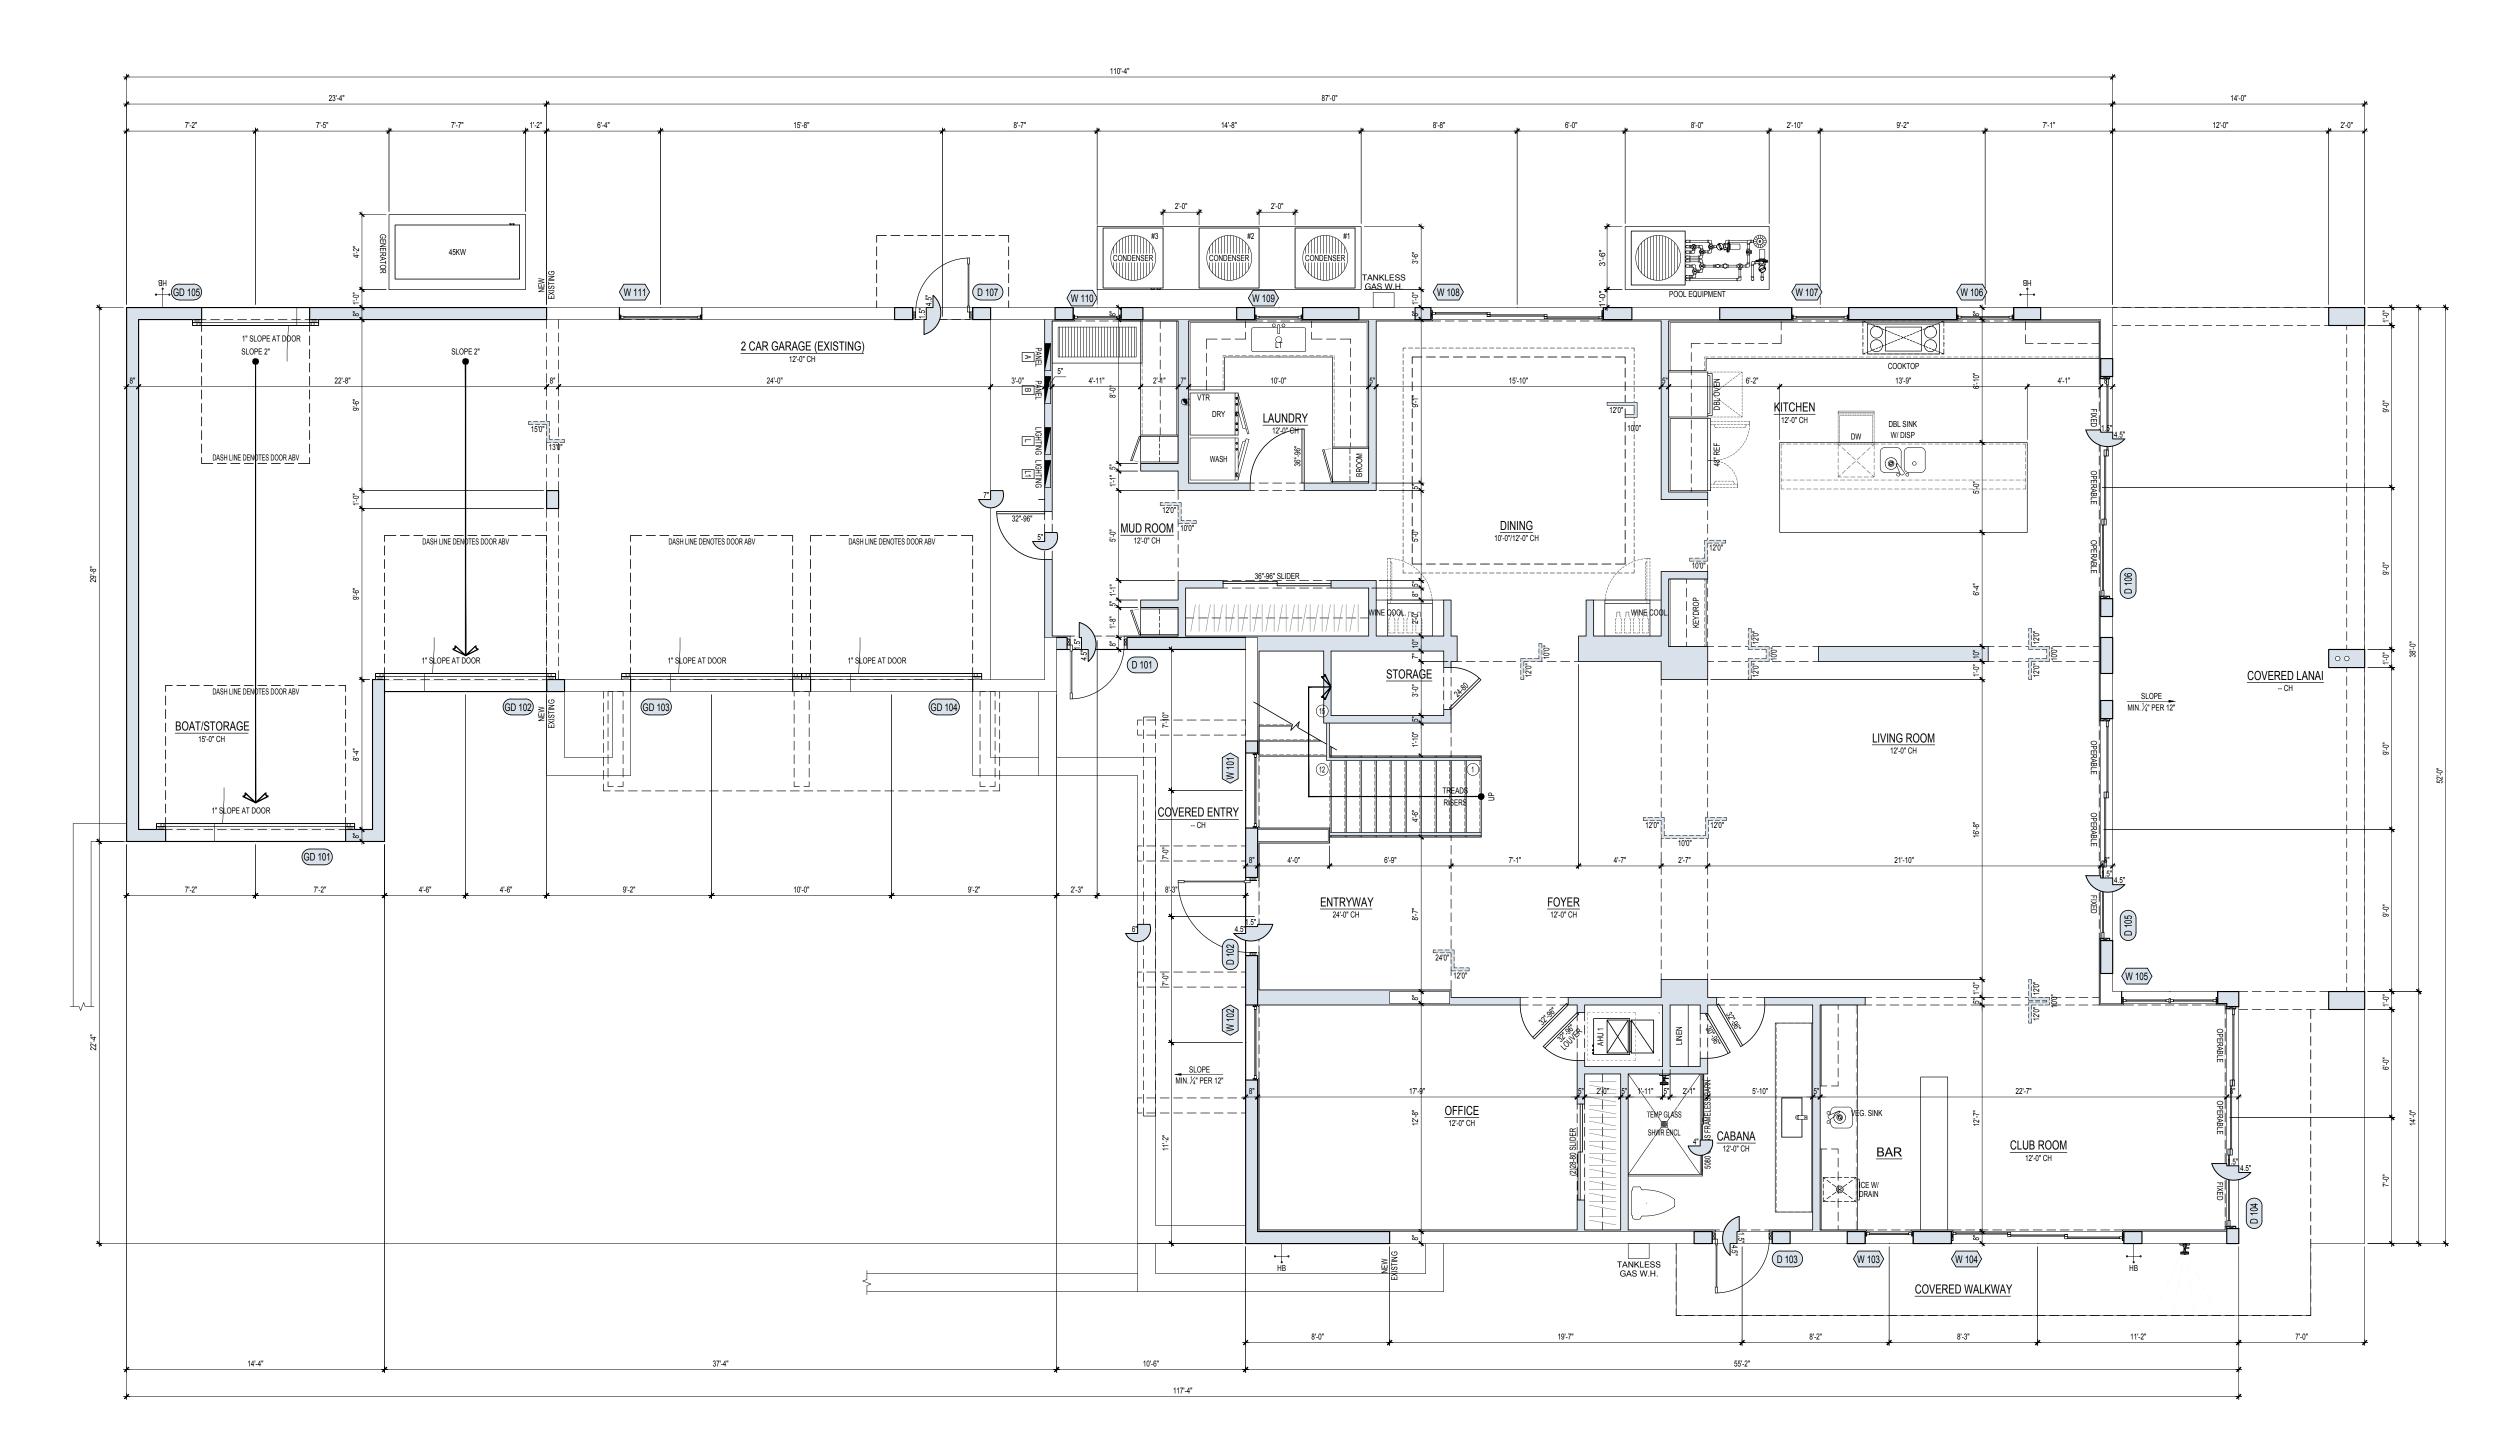

AREA CALCULA	TION
1ST FLOOR UNDER A/C	2815 SQ. F1
2ND FLOOR UNDER A/C	3237 SQ. F1
TOTAL UNDER A/C SQUARE FOOTAGE	6052 SQ. F1
GARAGE	1209 SQ. F1
COVERED ENTRY	124 SQ. F1
COVERED LANAI	539 SQ. F1
MASTER BEDROOM BALCONY	539 SQ. F1
SUITE #4 BALCONY	121 SQ. F7
OUTDOOR KITCHEN	180 SQ. F7
TOTAL GROSS SQUARE FOOTAGE	8764 SQ. F1

		FLOOR PI	LAN NOTES		
1.		WINDOWS AND DOORS TO B	E IMPACT RESISTANT AN	ID FULLY CAULKED FOR A	
2.	WEATHER TIGHT CONDITION. VERIFY AND COORDINATE ALL MASONRY OPENINGS WITH THE WINDOW/DOOR				
	MANUFACTURERS/SUPPLIER PRIOR TO CONSTRUCTION.				
3.		LIGHTS WITHIN 24" OF DOOF			
		URES WITH SILLS LESS THA ALL GLASS IN FRENCH DOO		OR2 AND SHOWERS SHAL	
4.	CEILINGS AND WALLS UNDER STAIR MUST BE ONE (1) HOUR RATED CONSTRUCTION.				
5.	STAIR SHALL BE FIRESTOPPED (SEE SECTION)				
6. 7.	PICKETS IN ALL BALUSTRADES MUST BE SPACED TO PREVENT PASSAGE OF A 4" OBJECT. BATHROOM FLOORS AND BASES SHALL BE OF AN IMPERVIOUS MATERIAL				
8.		RIOR BLOCK WALL WITH A N			
9.		9. INSULATE EXTERIOR FRA		*	
		SHALL TAKE PRECEDENCE S SHALL BE WRAPPED W/ 2			
9. 10.		IG & NAILING WHEN APPLIC			
	EXPOSURE 1, C-D GRADE PLYWOOD, INSTALLED PER MANF. RECOMMENDATION & NAILED WITH				
11.		SHANK NAILS @ 6" O.C. IN F ED AND FIRESTOPPED 1X2			
11.	INTERSECTION.	LU ANUT INLOTOFFED INZ	FTT UNKING HUKIZUNTA	IL W CLILING/WALL	
12.	PROVIDE SCREE	ENED VENTS @ FLOOR LEVE			
13.	EGRESS WINDOWS SHALL BE OPERABLE FROM THE INSIDE WITHOUT THE USE OF TOOLS. THE				
	SHALL PROVIDE A CLEAR OPENING OF NOT LESS THAN 20" WIDE & 24" HIGH AND 5.7 SQUARE FEET MINIMUM AREA. THE BOTTOM OF THE OPENING SHALL NOT BE MORE THAN 44" ABOVE				
	FLOOR AND LATCH AT 54" ABOVE FLOOR MAXIMUM.				
14.		SHALL DISPLAY LABELS SH	OWING COMPLIANCE WI	TH THE FLORIDA ENERGY	
15.	CODE.	O CLEARANCE GAS VENTE) FIREPLACE W/ NON CO	MBUSTABI F FINISH 1'-4"	
	WIDE AROUND	THE OPENING 1'-8" NON COM	MBUSTABLE HEARTH		
16.		O CLEARANCE GAS VENTLE FHE OPENING 1'-8" NON CON		OMBUSTABLE FINISH 1'-4'	
	WIDE / INCOME		& SYMBOLS		
		MASONRY CONST.	X O I IVIDOLO	NON-BEARING FRAME	
Ш		TYPICAL		CONSTRUCTION	
0	0	POURED CONCRETE		NEW WALLS	
		GROUT FILLED CELL		(RENOVATIONS ONLY) FRAME CONSTRUCTION	
Ξ	0	(SEE FOUNDATION PLAN)		ABOVE OR BELOW	
		ARCHED OPENING SEE	2 DETAIL NO. A8 SHEET NO.	DETAIL INDICATION	
		PLAN OR ELEV. BEARING FRAME	+	DENOTES DOOR AND	
		CONSTRUCTION	(2)30-80 FEET INCHES	WINDOW SIZE (TYPICAL)	
			LAN NOTES		
1.	GARAGE DOOR		LAN NOTES	WINDOW SIZE (TYPICAL)	
1. 2.	GARAGE DEMIS	FLOOR P INTO HOUSE SHALL BE "C" L ING WALL AND BEARING WA	LAN NOTES ABEL SOLID CORE WITH LLS SHALL BE MINIMUM	WINDOW SIZE (TYPICAL) A SELF CLOSING DEVISE ONE (1) HOUR RATED	
	GARAGE DEMIS CONSTRUCTION	FLOOR P INTO HOUSE SHALL BE "C" L ING WALL AND BEARING WA I 5/8" "TYPE"X" GYPSUM DRY	LAN NOTES ABEL SOLID CORE WITH LLS SHALL BE MINIMUM	WINDOW SIZE (TYPICAL) A SELF CLOSING DEVISE ONE (1) HOUR RATED	
	GARAGE DEMIS CONSTRUCTION MINIMUM R-11 IN	FLOOR P INTO HOUSE SHALL BE "C" L ING WALL AND BEARING WA I 5/8" "TYPE"X" GYPSUM DRY NSULATION.	LAN NOTES ABEL SOLID CORE WITH ALLS SHALL BE MINIMUM //WALL BOTH SIDES OF S	A SELF CLOSING DEVISE ONE (1) HOUR RATED TUDS @ 16" O.C. WITH	
2.	GARAGE DEMIS CONSTRUCTION MINIMUM R-11 IN GARAGE CEILIN DRYWALL ON 1)	FLOOR P INTO HOUSE SHALL BE "C" L ING WALL AND BEARING WA I 5/8" "TYPE"X" GYPSUM DRY	LAN NOTES ABEL SOLID CORE WITH ALLS SHALL BE MINIMUM WALL BOTH SIDES OF ST E AS FOLLOWS: (1) LAYER	A SELF CLOSING DEVISE ONE (1) HOUR RATED TUDS @ 16" O.C. WITH	
 3. 	GARAGE DEMIS CONSTRUCTION MINIMUM R-11 IN GARAGE CEILIN DRYWALL ON 1X TRUSSES	FLOOR P INTO HOUSE SHALL BE "C" L ING WALL AND BEARING WA I 5/8" "TYPE"X" GYPSUM DRY NSULATION. G CONSTRUCTION SHALL B (3 WOOD FURRING @ 16" O.	LAN NOTES ABEL SOLID CORE WITH ALLS SHALL BE MINIMUM WALL BOTH SIDES OF S' E AS FOLLOWS: (1) LAYEL C. ON PRE-ENGINEERED	A SELF CLOSING DEVISE ONE (1) HOUR RATED TUDS @ 16" O.C. WITH R 5/8" TYPE "X" GYPSUM & APPROVED ROOF	
2.	GARAGE DEMIS CONSTRUCTION MINIMUM R-11 IN GARAGE CEILIN DRYWALL ON 1X TRUSSES GARAGE CEILIN	FLOOR P INTO HOUSE SHALL BE "C" L ING WALL AND BEARING WA I 5/8" "TYPE"X" GYPSUM DRY NSULATION. G CONSTRUCTION SHALL B (3 WOOD FURRING @ 16" O. G CONSTRUCTION SHALL B	LAN NOTES LAN MINIMUM LAYER LAN NOTES LAYER LAN NOTES LAYER LAN LAYER LAYER LAN LAYER LAYER LAN LAYER LAYER	WINDOW SIZE (TYPICAL) A SELF CLOSING DEVISE ONE (1) HOUR RATED TUDS @ 16" O.C. WITH R 5/8" TYPE "X" GYPSUM & APPROVED ROOF	
 3. 	GARAGE DEMIS CONSTRUCTION MINIMUM R-11 IN GARAGE CEILIN DRYWALL ON 1X TRUSSES GARAGE CEILIN DRYWALL ON 1/2	FLOOR P INTO HOUSE SHALL BE "C" L ING WALL AND BEARING WA I 5/8" "TYPE"X" GYPSUM DRY NSULATION. G CONSTRUCTION SHALL B (3 WOOD FURRING @ 16" O.	LAN NOTES ABEL SOLID CORE WITH ALLS SHALL BE MINIMUM WALL BOTH SIDES OF S' E AS FOLLOWS: (1) LAYE C. ON PRE-ENGINEERED E AS FOLLOWS: (1) LAYE RING @ 16" O.C. ON PRE	WINDOW SIZE (TYPICAL) A SELF CLOSING DEVISE ONE (1) HOUR RATED TUDS @ 16" O.C. WITH R 5/8" TYPE "X" GYPSUM & APPROVED ROOF	

1ST FLOOR PLAN
SCALE: 3/16" = 1'-0"

A2.0

NELSON RENOVATION
2781 N.E. 3RD STREET
POMPANO BEACH, FL 33062